

EROSION/SEDIMENT CONTROL REPORT SECTION 1 - CONSTRUCTION SEQUENCE AND PROCEDURE THE FOLLOWING REPRESENTS THE PROPOSED CONSTRUCTION SEQUENCE.

- 1. FLAG CLEARING LIMITS AS SHOWN.
- NSTALL TEMPORARY QUARRY ROCK CONSTRUCTION ENTRANCES.
   INSTALL FILTER FENCE. CLEAR AND GRUB SITE. INSTALL TEMPORARY EROSION CONTROL MEASURES (SILT FENCE) AS CONSTRUCTION PROGRESSES. ADDITIONAL FILTER FENCE MAY BE REQUIRED AROUND THE PERIMETER TO PREVENT
- SILT LADEN WATER FROM LEAVING THE SITE.

  4. ANY AREA STRIPPED OF VEGETATION, WHERE NO FURTHER WORK IS ANTICIPATED FOR A PERIOD OF 1 DAYS (2 DAYS DURING WET SEASON), SHALL BE IMMEDIATELY STABILIZED WITH THE APPROVED EROSION & SEDIMENT CONTROL
- METHODS, (E.G., SEEDING, MULCHING. NETTING, EROSION & SEDIMENT CONTROL METHODS.)

  5. ROUGH GRADE SITE, CONSTRUCT RESIDENCE AND DRIVEWAY.
- 6. HYDROSEED AND MULCH ALL EXPOSED AREAS. 1. REMOVE TEMPORARY EROSION CONTROL FACILITIES, ONLY, AFTER ENTIRE SITE IS STABILIZED AND THE POTENTIAL
- FOR EROSION HAS PASSED.

  8. CLEAN ANY SILT THAT HAS ACCUMULATED IN THE PERMANENT STORM DRAINAGE SYSTEM.

EROSION/SEDIMENT CONTROL REPORT SECTION 2 - SOIL STABILIZATION AND SEDIMENT TRAPPING.

A TEMPORARY QUARRY SPALL/ROCK CONSTRUCTION ENTRANCE WILL BE INSTALLED AT THE BEGINNING OF ANY SITE DEVELOPMENT. THIS WILL ADEQUATELY PREVENT SEDIMENT FROM LEAVING THE SITE. IN ADDITION TO THE CONSTRUCTION ENTRANCE, SILT FENCE SHALL BE INSTALLED

DOWN GRADIENT FROM GRADED AREAS.

EROSION/SEDIMENT CONTROL REPORT SECTION 3 - PERMANENT EROSION CONTROL AND SITE RESTORATION.

THE SITE SHALL BE PERMANENTLY STABILIZED WITH PAVED OR OTHER HARD SURFACING FOR THE DRIVEWAY, CONSTRUCTION OF THE STRUCTURE, APPLICATION OF TYPICAL LANDSCAPING AND SEEDING ALL EXPOSED GRADED AREAS.

EROSION/SEDIMENT CONTROL REPORT SECTION 4 - GEOTECHNICAL ANALYSIS AND REPORT

EROSION/SEDIMENT CONTROL REPORT SECTION 5 - INSPECTION SEQUENCE EROSION CONTROL FACILITIES SHOULD BE INSPECTED AFTER ANY SIGNIFICANT RAINFALL EVENT (GREATER THAN Ø.5 INCHES IN 24 HRS) OR AT LEAST ONCE A WEEK. ANY SEDIMENT THAT HAS ACCUMULATED SHOULD BE REMOVED AND STOCKPILED ON SITE.

EROSION/SEDIMENT CONTROL REPORT SECTION 6 - CONTROL OF POLLUTANTS OTHER THAN SEDIMENTS

IT WILL BE THE CONTRACTOR'S RESPONSIBILITY TO ENSURE THAT EQUIPMENT USED OR PARKED ON-SITE IS WELL MAINTAINED AND DOES NOT REPRESENT A POTENTIAL SOURCE OF POLLUTION. EQUIPMENT SHOULD BE STORED IN A COMMON LOCATION ON SITE. ALL RE-FUELING AND MAINTENANCE ACTIVITIES SHOULD BE CARRIED OUT IN COMMON LOCATION FOR ALL ON-SITE EQUIPMENT.


EROSION/SEDIMENT CONTROL REPORT SECTION 1 - UTILITIES

SHALLOW UTILITIES WILL BE INSTALLED TO THE SITE AS PART OF THE SITE DEVELOPMENT WORK, TRENCHING IS EXPECTED TO BE MINIMAL. NO FURTHER REQUIREMENTS ARE ANTICIPATED.


	TYPE BO	TANICAL / COMMON NAME	QUANTITY	SIZE
	TREE TREE	LELAND CYPRESS ALASKAN WEEPING CEDAR	2 2	5' HEIGHT 6-8' HEIGHT
***	SHRUB SHRUB SHRUB	PIERIS (VARIETY OF COLORS) BURGUNDY WINE NANDINA BUNTING BUSH	2 4 3	5 GALLON 5 GALLON 5 GALLON
	GROUND COVER	KINNIKINNICK	Ø	1 GALLON

## LANDSCAPE NOTES:

- I. CREATE A 15' FIRE DEFENSE BUFFER AROUND HOUSE PERIMETER. REMOVE DEAD TREE LIMBS TO A HEIGHT OF 10' AND REMOVE ALL SURFACE COMBUSTIBLE MATERIALS.
- 2. TEMPORARILY IRRIGATE NEW PLANTINGS WITH BIDDER / DESIGNER DRIP IRRIGATION. SEE PLANS FOR LOCATIONS. NO PERMANENT IRRIGATION PROPOSED FOR THIS PROJECT
- 3. RETAIN AND PROTECT EXISTING NATIVE TREES NOT IMPACTED BY CONSTRUCTION.
- 4. PLACE SHRUBS AND START WORK IN FIELD PER OWNER'S DIRECTIONS.
- 5. PIT PLANT TREES AND SHRUBS IN 50/50 NATIVE SOIL AND COMPOST.
- 6. PROVIDE WILDFLOWER/GRASS SEED MIX IN RE-GRADED AREAS. SEE SUNCADIA WEBSITE FOR APPROVED SEED MIX ORDER FORMS.

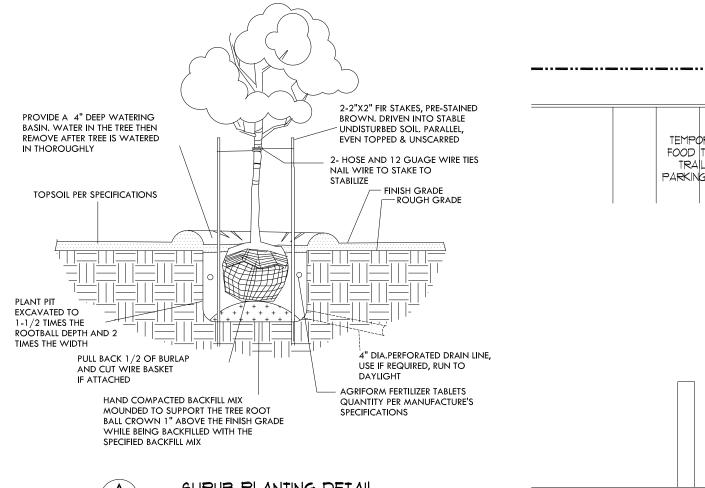



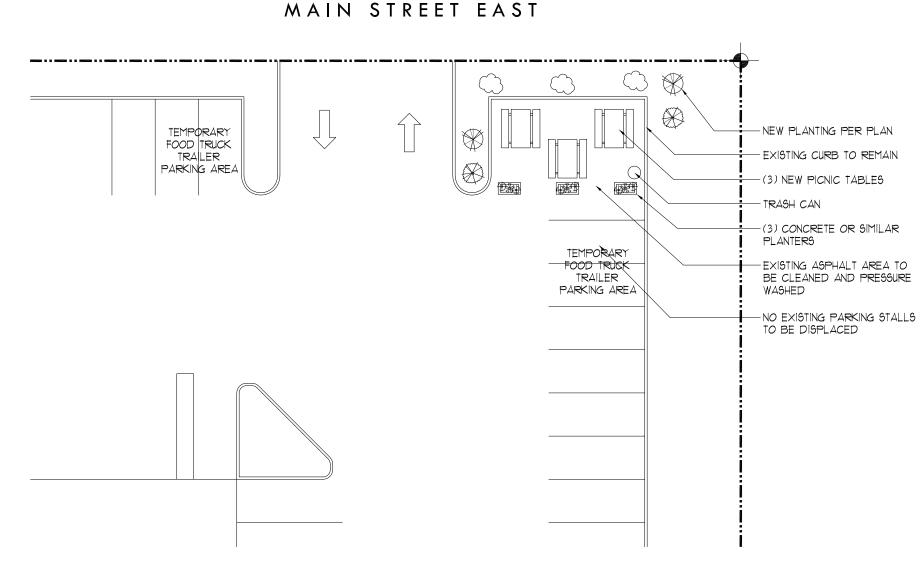


OUTDOOR SEATING

PULL BACK 1/2 OF BURLAP

HAND COMPACTED BACKFILL MIX

MOUNDED TO SUPPORT THE TREE ROOT

BALL CROWN 1" ABOVE THE FINISH GRADE WHILE BEING BACKFILLED WITH THE SPECIFIED BACKFILL MIX

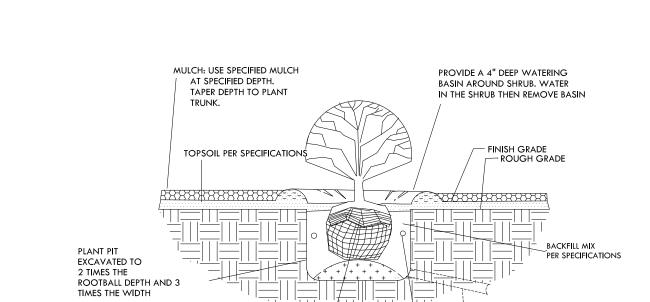

B SHRUB PLANTING DETAIL
ONE GALLON AND LARGER N.T.

4" DIA.PERFORATED DRAIN LINE.

USE IF REQUIRED, RUN TO


QUANTITY PER MANUFACTURE'S


AGRIFORM FERTILIZER TABLETS

SPECIFICATIONS

 $1'' = 2\emptyset' - \emptyset''$ 

SCALE 1/4" = 1'-0"

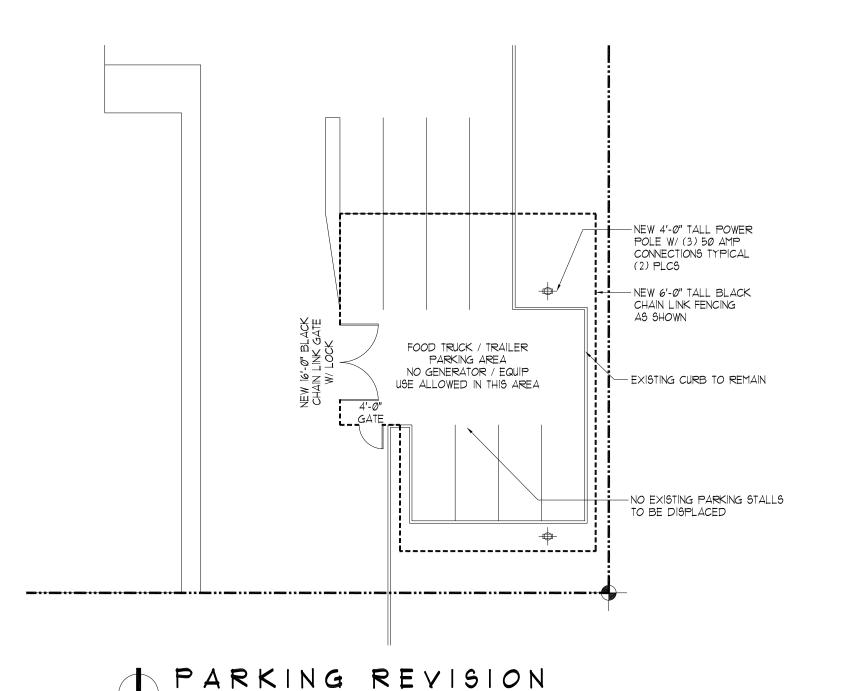

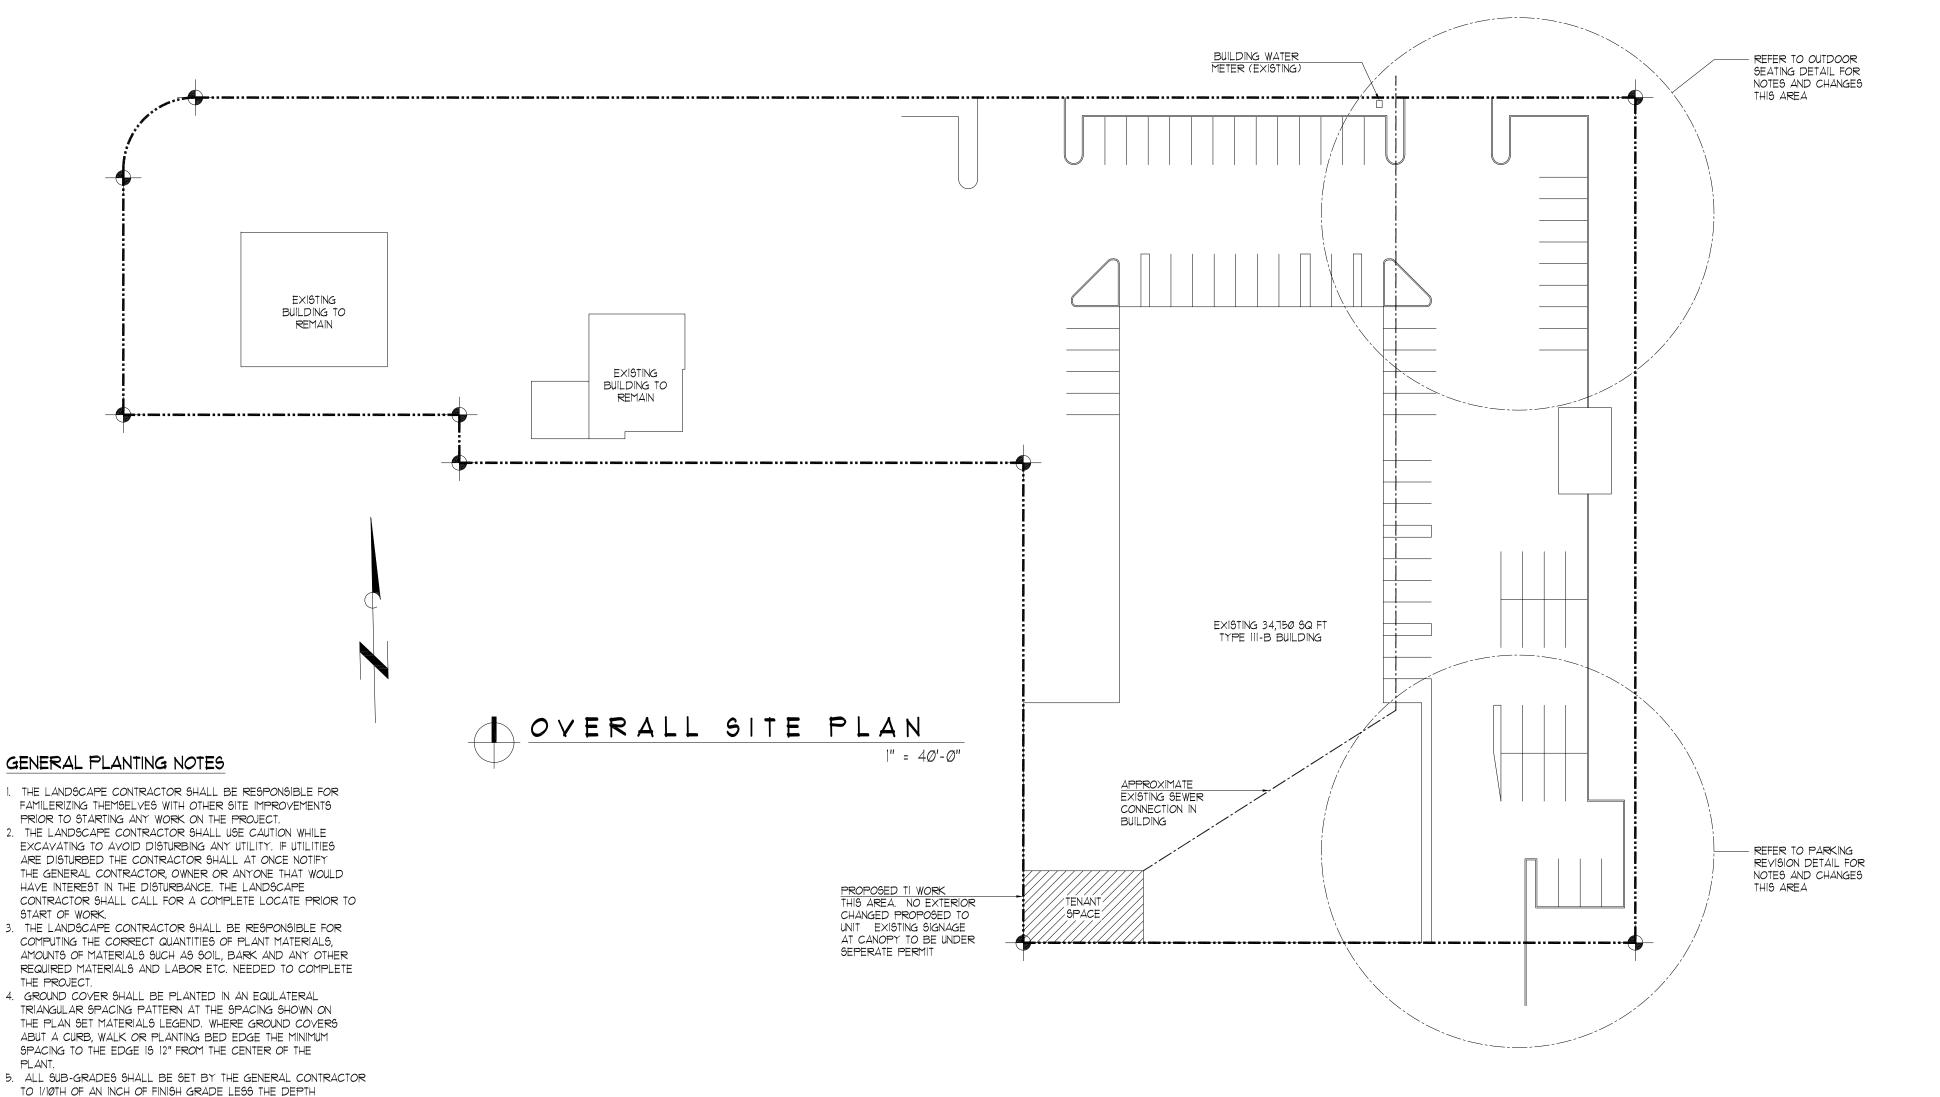

## BE USED IN ALL PLANTING AREAS. 1. ROTOTILL ALL PLANTING AREAS TO A DEPTH OF 8" EXCEPT AREAS THAT SLOPE AND TILLING WOULD JEOPERDISED STABILITY

6023 PARKER ROAD SUMNER, WA PARCEL #: 0520193223

SOUTH SOUND COMMISSARY KITCHEN

8. FERTILIZE ALL PLANTINGS WITH AGRO TRANSPLANT FERTILIZER
4-2-2 PER THE MANUFACTURERS SPECIFICATIONS.

9. FERTILIZE ALL PLANTINGS WITH AGRIFORM TABLETS PER THE MANUFACTURERS SPECIFICATIONS.

10. ALL PLANT MATERIALS SHALL CONFORM TO THE CURRENT EDITION

6. A MINIMUM DEPTH OF 4" THREE WAY IMPORTED TOPSOIL SHALL

OF THE A.A.N. STANDARDS FOR NURSERY STOCK.

ANY REPLACEMENTS OF DEAD OR DAMAGED STOCK SHALL BE COMPLETED AT ONCE.


11. THE LANDSCAPE CONTRACTOR SHALL MAINTAIN THE LANDSCAPE

OF THE SPECIFIED IMPORTED TOPSOIL DEPTH.

DURRING AND THROUGH CONSTRUCTION AND UNTIL FINAL ACCEPTANCE.

12. THE LANDSCAPE CONTRACTOR SHALL GUARANTEE AND WARANTEE
ALL MATERIALS AND WORKMANSHIP FOR A PERIOD OF ONE
YEAR AND/OR ONE COMPLETE GROWING SEASON

REVIEW #1 CUP-2024-0004

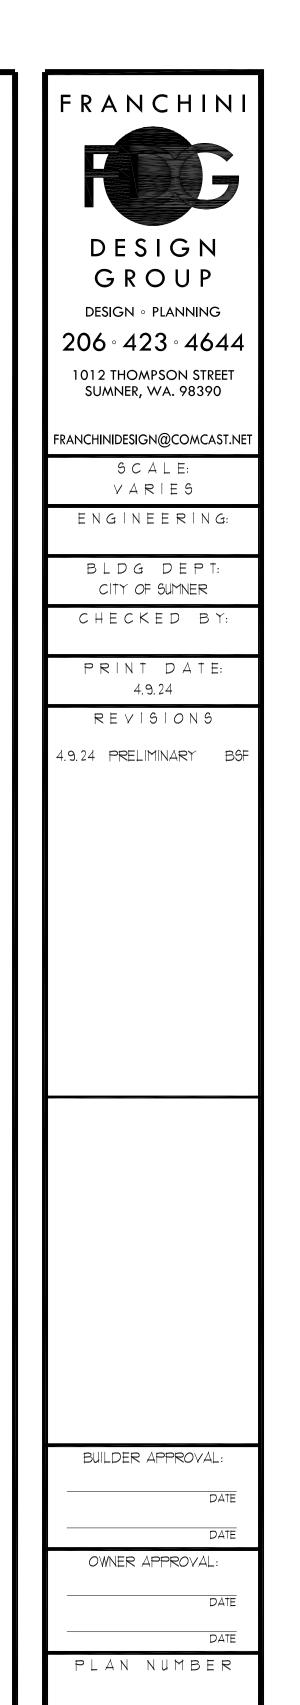

PROJECT

SOUTH

SOUND

COMMISSARY

6023

PARKER ROAD

SUMNER

WASHINGTON

SHEET TITLE:

SITE PLAN

SHEET NUMBER: